DIVISION OF INDUSTRY SERVICES
2331 SAN LUIS PL STE 150
GREEN BAY WI 54304-5211
Contact Through Relay
http://dsps.wi.gov/programs/industry-services
www.wisconsin.gov
Scott Walker, Governor
Laura Gutiérrez, Secretary



February 03, 2018

CUST ID No. 915451

ANDY BOECK TOTAL MECHANICAL W234 N2830 PAUL RD PEWAUKEE WI 53072

CONDITIONAL APPROVAL

PLAN APPROVAL EXPIRES: 01/02/2019

SITE:

First Citizens Bank & Trust Co 4000 W Brown Deer Rd Village of Brown Deer, 53209 Milwaukee County

FOR:

Facility: 607995 FIRST CITIZENS BANK & TRUST CO

4000 W BROWN DEER RD

* BROWN DEER 53209

ATTN: Buildings & Structures Building Inspector

BUILDING INSPECTION VILLAGE OF BROWN DEER 4800 W GREEN BROOK DR BROWN DEER WI 53223

(Please forward a copy of this letter to the fire department conducting inspections of this project.)

Identification Numbers

Transaction ID No. 3048424 Site ID No. 607995

Please refer to both identification numbers, above, in all correspondence with the agency.

CONDIT

DEPT OF SA

PROFESSION

DIVISION OF NOT

11,664 sq ft Area Heated

SITE REQUIREMENTS

Contact both the State Inspector and the local municipality PRIOR to the start of construction.

Tenant Name or Addn/Alt Description: First Citizens Bank and Trust/ Guaranty Bank

• A full-size copy of the approved plans, specifications and this letter shall be on-site during construction and open to inspection by authorized representatives of the Department, which may include local inspectors. If plan index sheets were submitted in lieu of additional full plan sets, a copy of this approval letter and index sheet shall be attached to plans that correspond with the copy on file with the Department. If these plans were submitted in an electronic form, the designer is responsible to download, print, and bind the full size set of plans along with our approval letter. A department electronic stamp and signature shall be on the plans which are used at the job site for construction.

The following conditions shall be met during construction or installation and prior to occupancy or use:

Object Type: HVAC ICC System Regulated Object ID No.: 1741620 Code Applies Date: 01/03/18

REMINDERS

- IMC 603.6.2.1 Provide flexible duct connectors which are listed and approved for such use, that are not over 14 ft in length, and convey air with a temperature less than 250 deg. F.
- IMC/SPS 364.0313(1) Every heating, ventilating and air-conditioning system shall be balanced upon installation. The person or agency responsible for balancing of the ventilating system shall document in writing the amount of outdoor air being provided and distributed for the building occupants, exhausts, and any other specialty ventilation. The document shall be retained at the site and shall be made available to the department upon request.
- The submittal described above has been reviewed for conformance with applicable Wisconsin Administrative Codes and Wisconsin Statutes. The submittal has been CONDITIONALLY APPROVED. The owner, as defined in chapter 101.01(10), Wisconsin Statutes, is responsible for compliance with all code requirements. Only those object types listed above have been approved; other submittals such as plumbing and those listed above under REQUIRED SUBMITTAL(S), may also be required.

3048

FEB 0

ANDY BOECK Page 2 2/3/2018

All permits required by the state or the local municipality shall be obtained prior to commencement of
construction/installation/operation. You are responsible for complying with state and federal laws concerning construction near or
on wetlands, lakes, and streams.

- This plan has not been reviewed for compliance with fire code requirements, including those for fire lanes and fire protection water supply, so contact the local fire department for further information.
- In granting this approval, the Division of Industry Services reserves the right to require changes or additions, should conditions arise making them necessary for code compliance. As per state stats 101.12(2), nothing in this review shall relieve the designer of the responsibility for designing a safe building, structure, or component. The Division does not take responsibility for the design or construction of the reviewed items.
- Per s. SPS 361.40(4), projects for buildings of over 50,000 cubic feet total volume shall have supervising professionals who file
 compliance statements with this agency and the local code officials prior to occupancy of the project. The compliance statement is
 available on our website. http://verification.dsps.wi.gov/IndustryServices/Commercial-Buildings-Compliance/DSPSMainForm.aspx

Inquiries concerning this correspondence may be made to me at the telephone number listed below, or at the address on this letterhead.

Sincerely,

Dave

Fee Required \$ 500.00


Fee Received \$ 500.00

Balance Due \$ 0.00

David Lintz Architect / Bldg. Plan Reviewer, Division of Industry Services (920)492-7728, Mon-Fri, 7:45 a.m. - 4:30 p.m. david.lintz@wi.gov

cc: Total Mechanical Inc

Betty J Wiese, State Building Inspector, (414) 852-3694, Monday, 7:45 A.M. - 4:30 P.M. Cindy Tinstsman, First Citizens

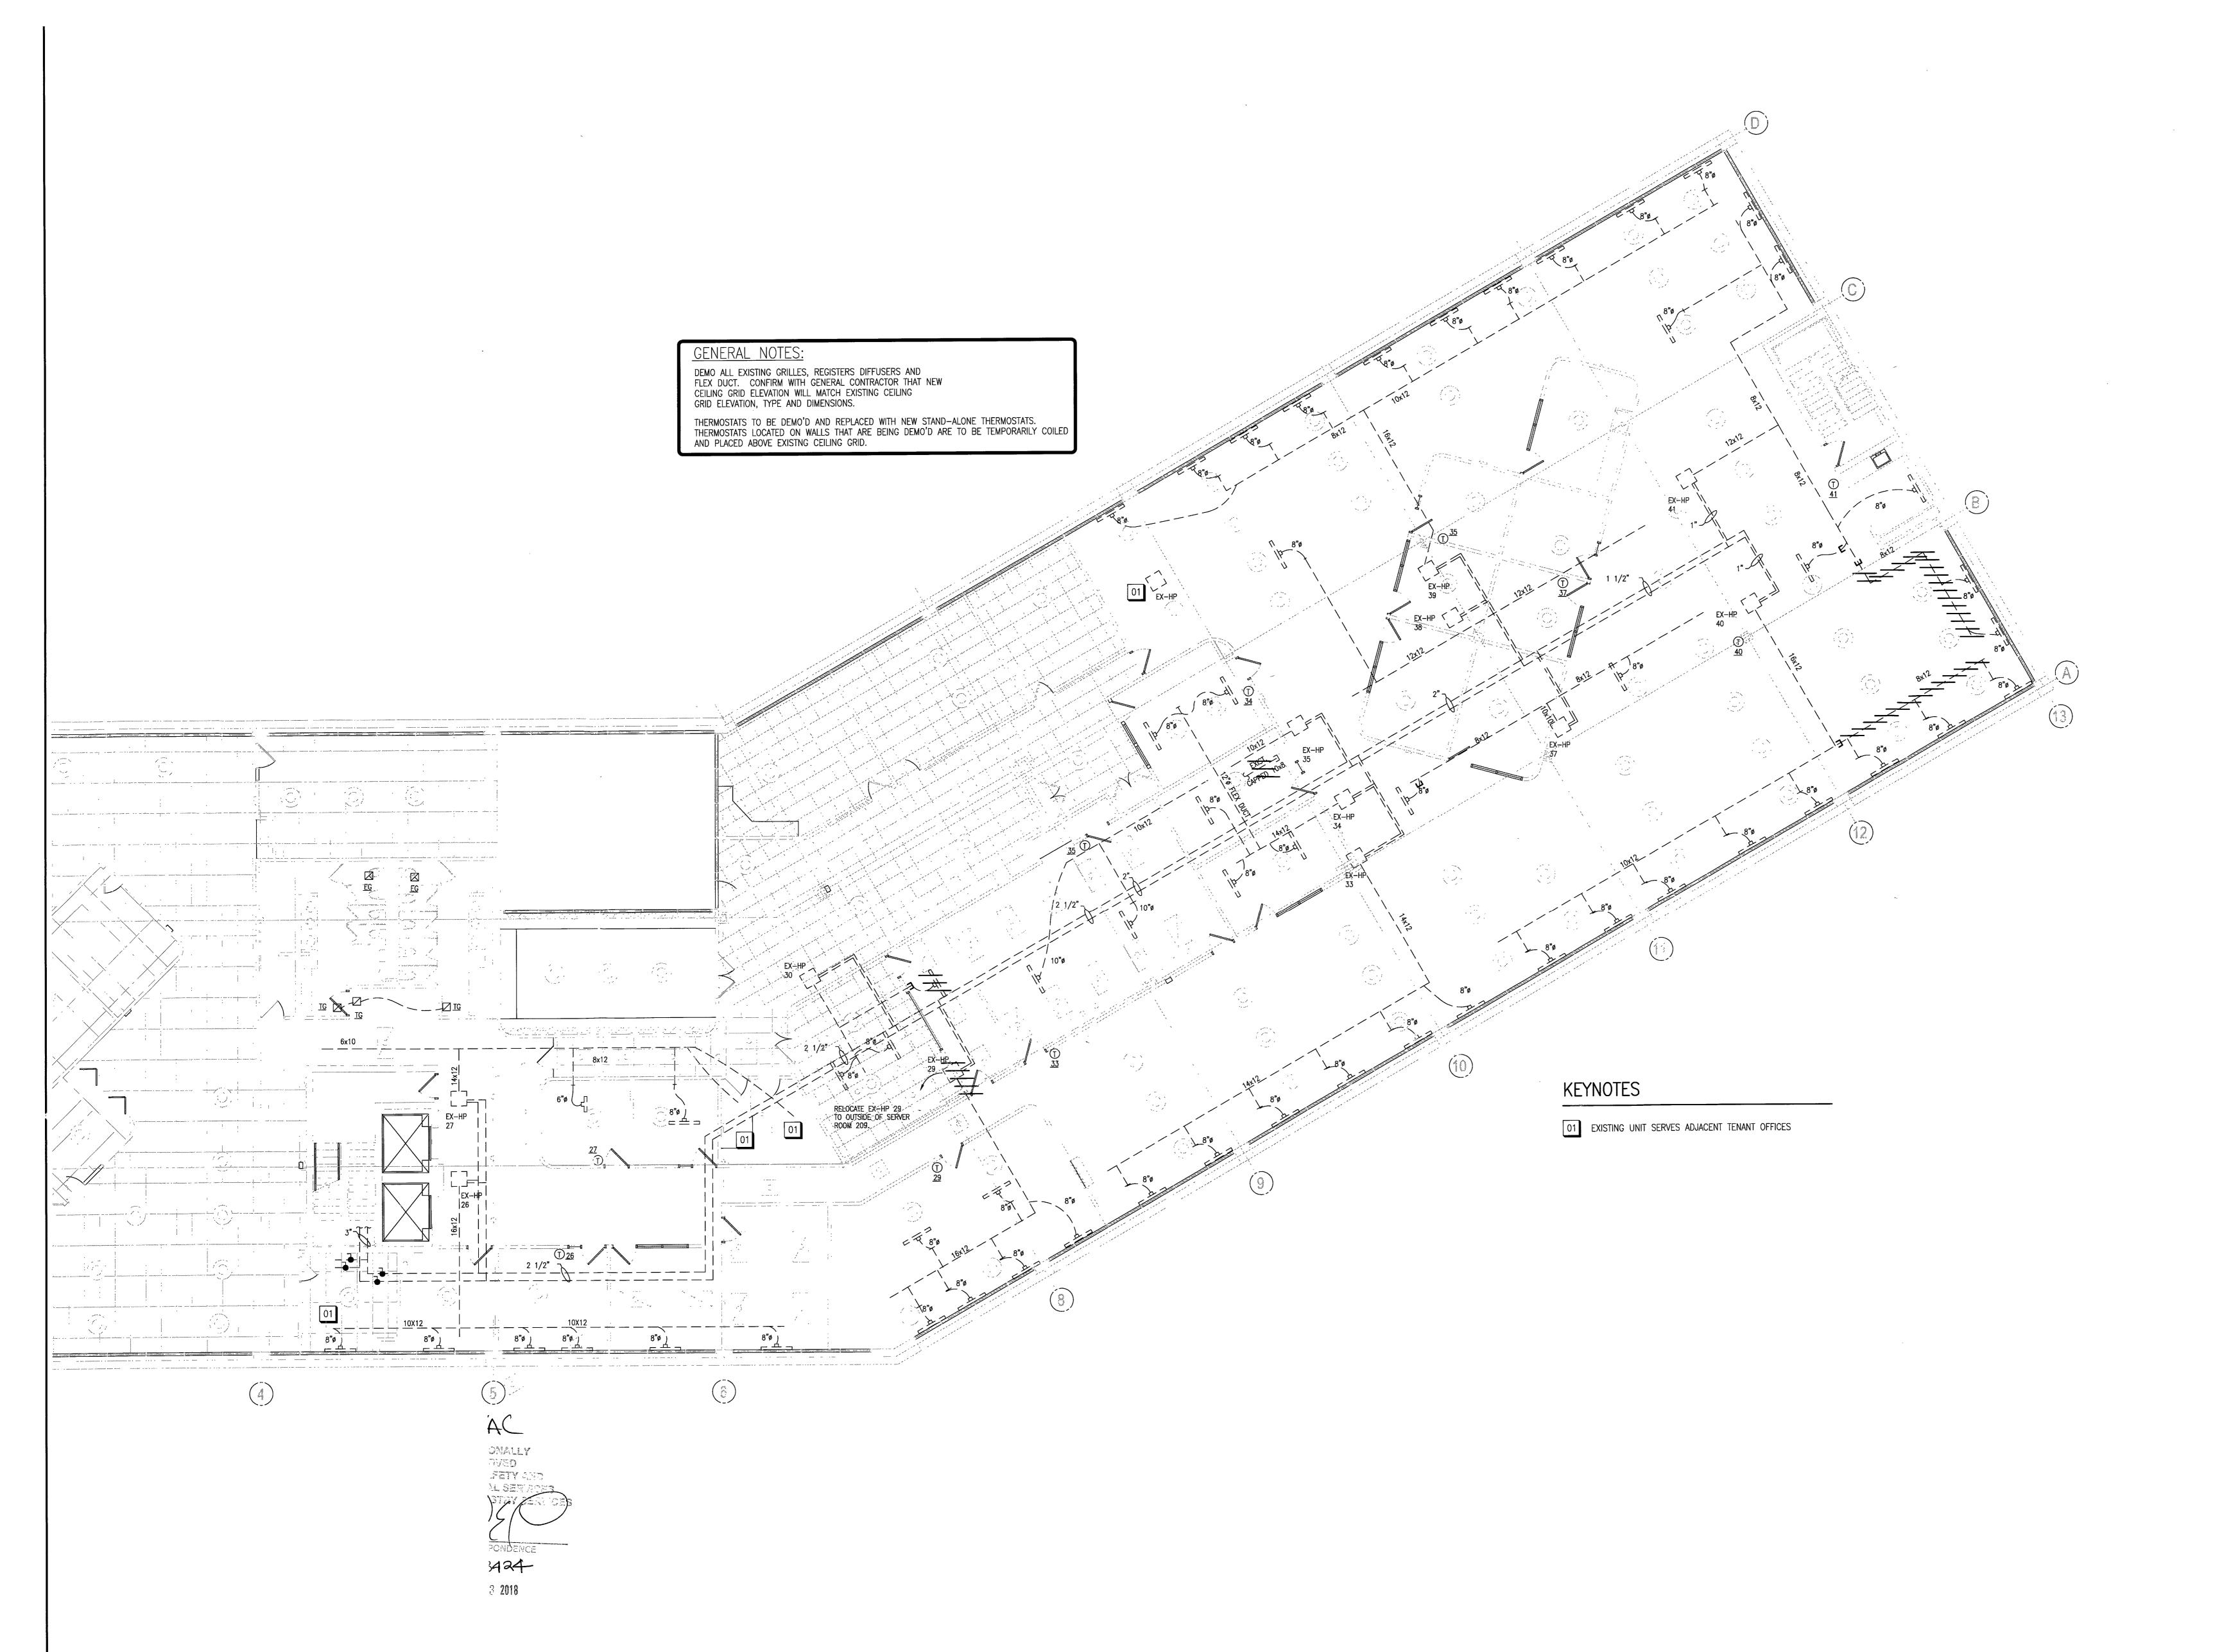

Partial Second Floor HVAC Demolition Plan

SCALE: 1/8" = 1'-0"



Building Integrity W234 N2830 PAUL ROAD PEWAUKEE WI. 53072

PHONE (262) 523-2500

FAX (262) 523-2530 TOTAL-MECHANICAL.COM

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1/29/18 State Plan Review

Partial Second Floor HVAC **Demolition Plan**

Project
First Citizens

Bank


4000 West Brown Deer Road Brown Deer, WI 53209

JOB # 12448 DANIELLE REX W/ TOTAL MECH 262-523-2500

January 12, 2018

Project No

Sheet No

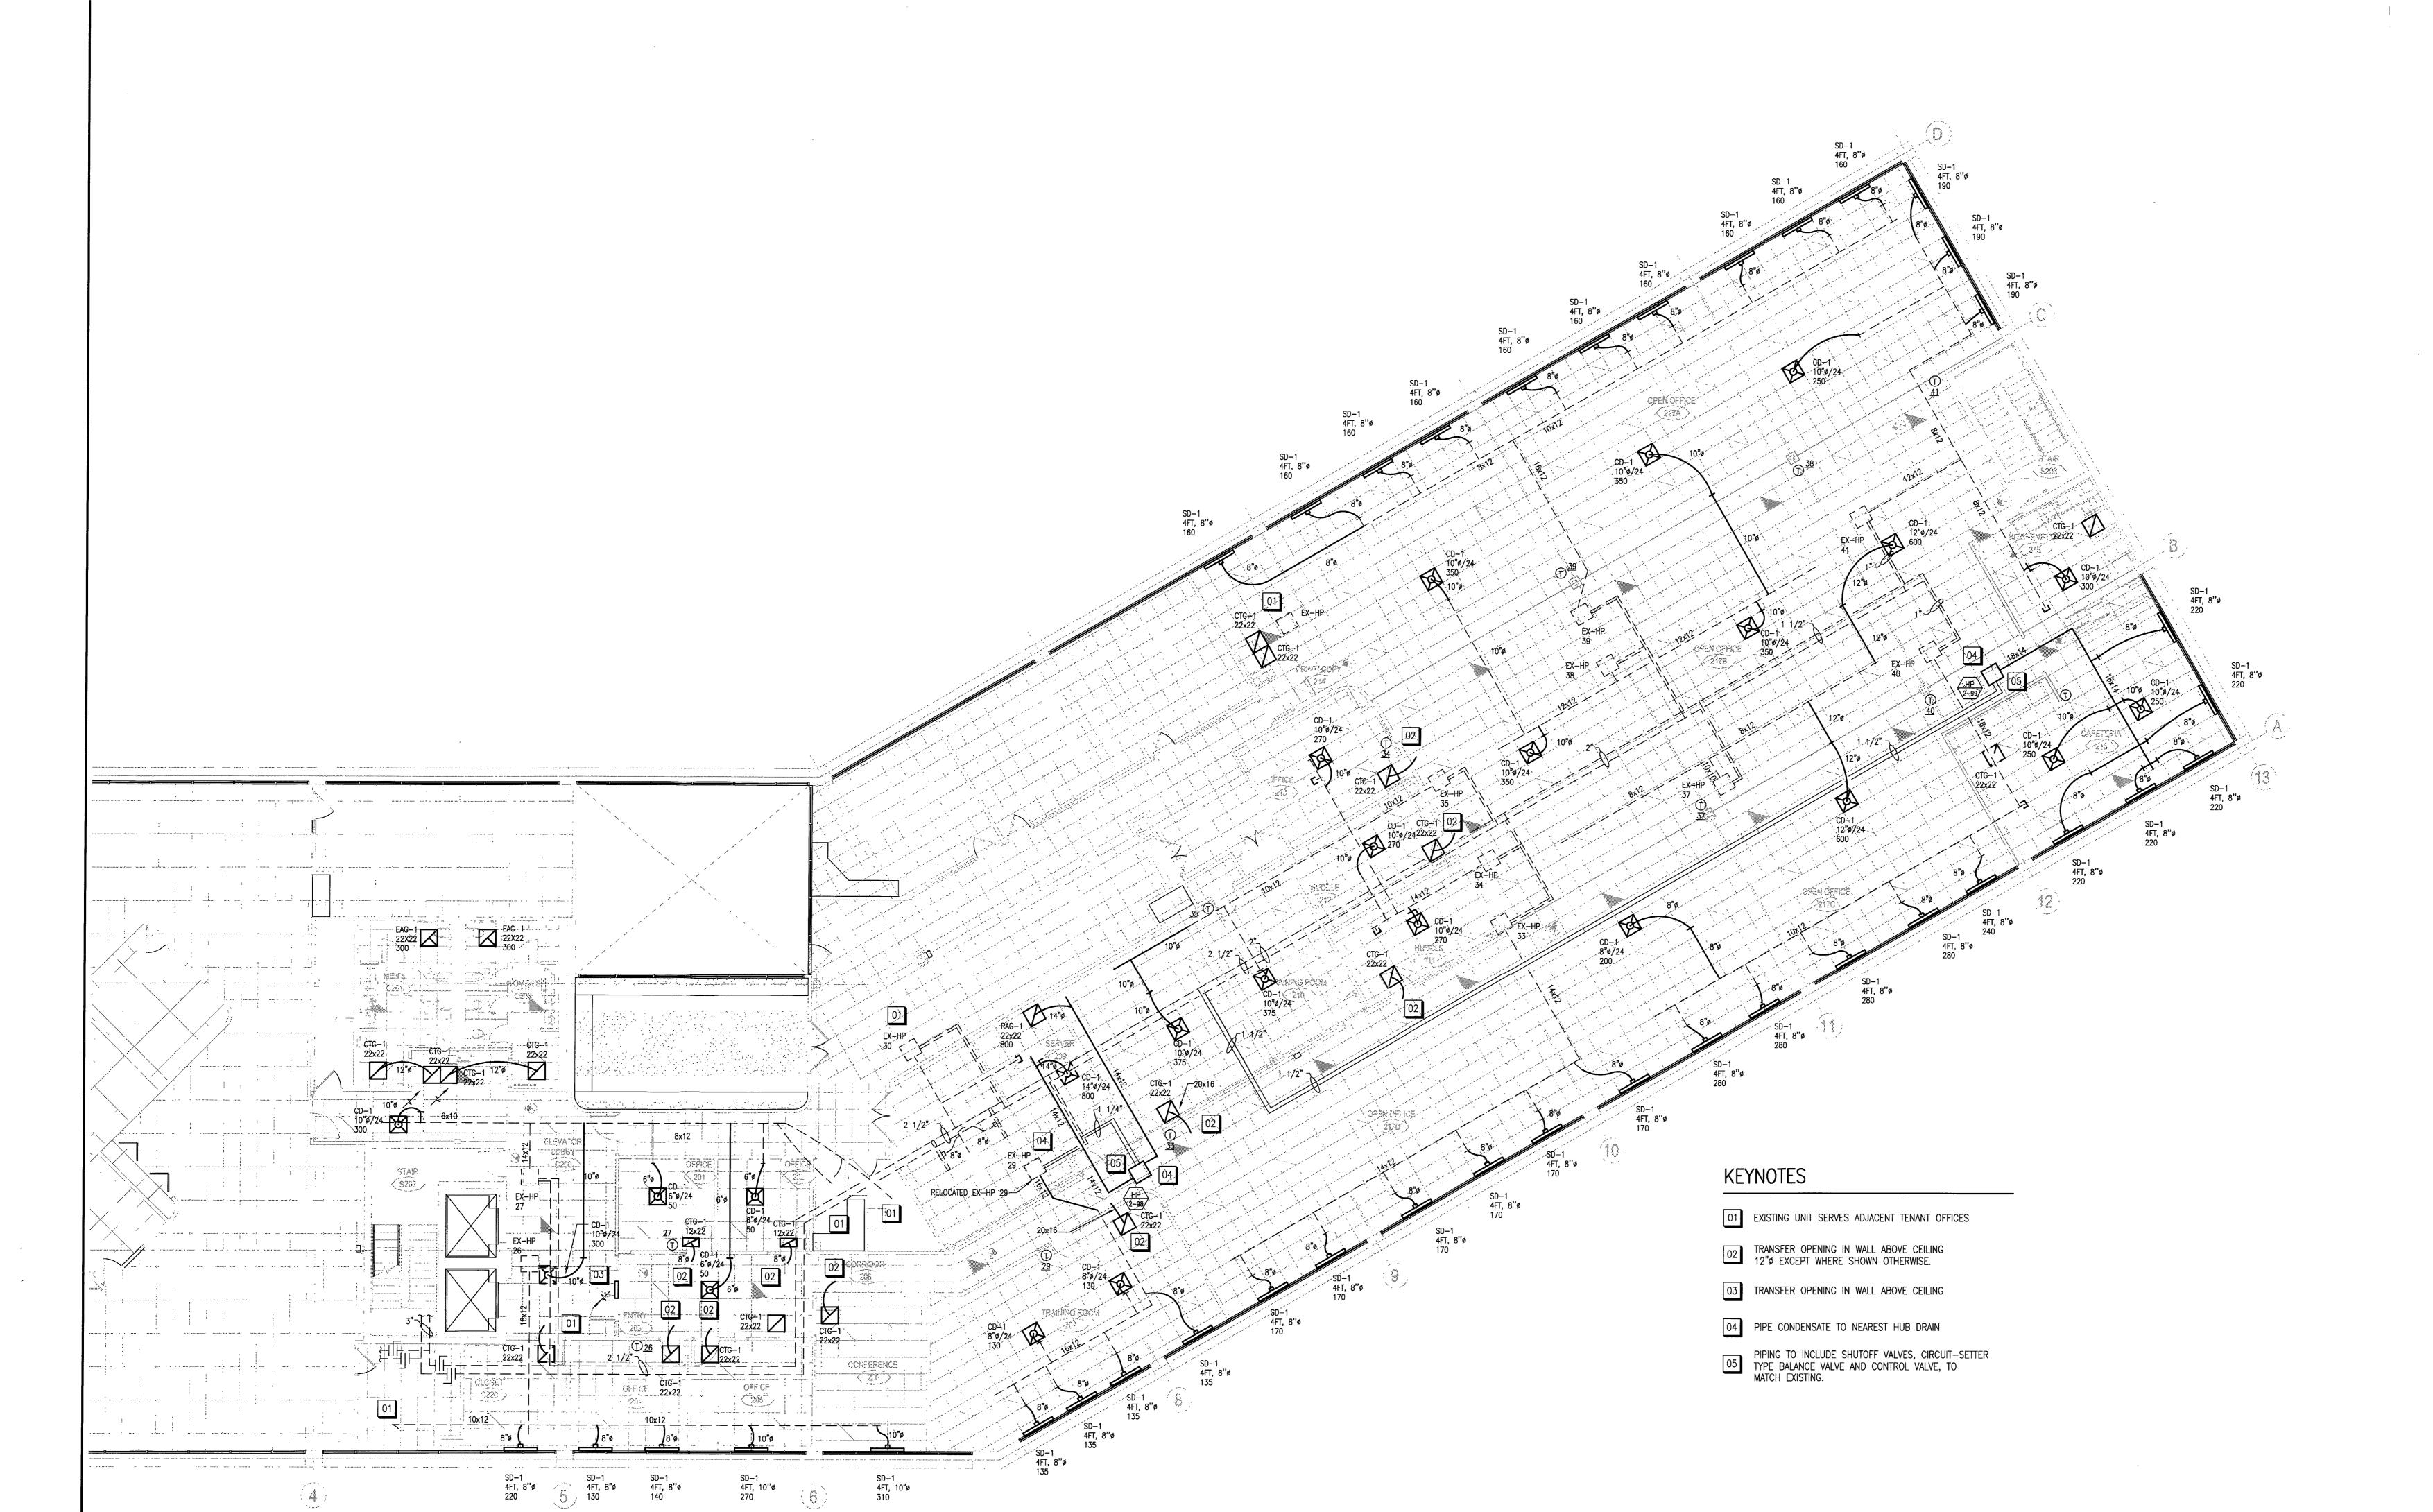



Building Integrity

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Revisions State Plan Review

Plan Review 1/29/18

Partial
Second Floor New
HVAC Plan

awn By: BK Reviewed B

Project
First Citizens
Bank

4000 West Brown Deer Road Brown Deer, WI 53209

Date

Date January 12, 2018

Project No 10xxx

ANDREW L.
BOECK
E39079
HALES CORNERS,
W:

Sheet No

M-2



HEAT P	HEAT PUMP UNIT SCHEDULE																
UNIT	AREA SERVED	MAKE	MODEL	SERIAL	REFRIGERANT		0514	ESP	WATER	HEATI	NG	COOL	ING		ELECT	RICAL	
TAG	ANEX SERVED	WIAIL	No.	No.	TYPE	FILTERS	CFM	"WG	GPM	MBH	COP	MBH	EER	MCA	MFS	VOLTAGE	REMARKS
EX HP-26	SEE PLAN	SNYDER GENERAL	CCH04ZAMTS	7WCZ6741-07	R-22/55 OZ	16.5x35.5x1	_	_	_	_	_	_	_	_	15	460/3/60	EXISTING UNIT. WIRE TO STAND-ALONE T-STAT
EX HP-27	SEE PLAN	SINGER	CC260B88	439460129	R-22/46 OZ	18.5x23.5x1	_	_	-	_	_	_	_	-	15	460/3/60	EXISTING UNIT. WIRE TO STAND-ALONE T-STAT. FUSE BLOWN ON 460 VOLT DISCONNECT.
EX HP-29	SEE PLAN	SINGER	CC260B88	439420234	R-22/48 OZ	18.5x23.5x1	_	_	_	_	_	_	_	-	15	460/3/60	EXISTING UNIT. WIRE TO STAND-ALONE T-STAT
EX HP-33	SEE PLAN	SINGER	CC330B88	439460115	R-22/67 OZ	18.5x23.5x1	_	_	_	_	_	_	_	_	15	460/3/60	EXISTING UNIT. WIRE TO STAND-ALONE T-STAT
EX HP-34	SEE PLAN	SINGER	CC330B88	439460103	R-22/46 OZ	18.5x23.5x1	_	-	_	_] -	_	_	_	15	460/3/60	EXISTING UNIT. WIRE TO STAND-ALONE T-STAT. UNIT HAS EXIST. NON-OPERATIONAL HUMIDIFER.
EX HP-35	SEE PLAN	SINGER	CC260B88	430050048	R-22/46 OZ	18.5x23.5x1	_	_	_	_	_	_	_	_	15	460/3/60	EXISTING UNIT. WIRE TO STAND-ALONE T-STAT. UNIT WON'T RUN. BAD CONTROLLER OR T-STAT.
EX HP-37	SEE PLAN	SINGER	CC520B88	439480023	R-22/80 OZ	18.5x32.5x1	_	-	_	_	_	_	_	-	15	460/3/60	EXISTING UNIT. WIRE TO STAND-ALONE T-STAT
EX HP-38	SEE PLAN	SINGER	CC400B88	439420236	R-22/68 OZ	18.5x23.5x1	_	-		_	-	_	_	_	15	460/3/60	EXISTING UNIT. WIRE TO STAND-ALONE T-STAT
EX HP-39	SEE PLAN	FLORIDA HEAT PUM	P EC041-4H2C-FRS	3540-303-000001-7111m26377	R-410A/70 OZ	20x16x1	_	-	_	_	_	_	·-	_	15	460/3/60	EXISTING UNIT. WIRE TO STAND-ALONE T-STAT
EX HP-40	SEE PLAN	JCI	RBSH042SR400CANUA7N02SSF	170800729	R-410A/70 OZ	18x18x2	_	_	_	_	-	_	_	_	15	460/3/60	EXISTING UNIT. WIRE TO STAND-ALONE T-STAT
EX HP-41	SEE PLAN	SINGER	CC330B88	439460116	R-22/57 OZ	18.5x23.5x1	_	-	_	-	<u> </u>	-	-	_	15	460/3/60	EXISTING UNIT. WIRE TO STAND-ALONE T-STAT
HP-2-99	CAFETERIA 216	TRANE	GEHE0604-*BL0	_	R-410A	1"	1,600	0.515	16.4	57.85	4.36	57.74	13.0	12.45	_	460/3/60	WIRE TO STAND-ALONE T-STAT. 10.50 FLA
HP-2-98	SERVER 209	TRANE	GEHE0244-*0BL0	_	R-410A	1"	800	0.602	6.7	24.30	4.55	22.86	13.6	5.45	_	460/3/60	WIRE TO STAND-ALONE T-STAT. 4.55 FLA

NOTES: MCA = MINIMUM CIRCUIT AMPS MFS = MAXIMUM FUSE SIZE

DIFFUSE	R, REGISTER &	& GRILLE	SCHEDULE			
UNIT TAG	MANUFACTURER	MODEL	TYPE	MOUNTING	REMARKS	
CD-1	PRICE	SPD	CEILING PLAQUE DIFFUSER	LAY-IN	ROUND NECK, 4-WAY THROW	-
RAG-1	PRICE	530	RETURN AIR GRILLE	LAY-IN	STEEL LOUVERED	
EAG-1	PRICE	530	EXHAUST AIR GRILLE	LAY-IN	STEEL LOUVERED	
CTG-1	PRICE	530	CEILING TRANSFER GRILLE	LAY-IN	STEEL LOUVERED	
SD-1	PRICE	SDS100	SLOT DIFFUSER	T-BAR	4'-0", 1" 2-SLOT, 2-WAY	

PIPING MINIMUM IN	SULATIO	N TABLE (IN)					
	NOMINAL PIPE DIAMETER						
FLUID							
	≤ 1.5"	>1.5"					
STEAM	1.5"	3"					
HOT WATER	1.5"	2"					
CHILLED WATER BRINE OR REFRIGERANT	1.5"	1.5"					

1. PIPING THAT CONVEYS FLUIDS THAT HAVE A DESIGN OPERATING TEMPERATURE RANGE BETWEEN 55°F AND 105°F.

DUCT INSULATION TABLE (MINIMUM R)			
DUCT LOCATION	DUCT TYPE	TEMP. DIFF.	HEATING & COOLING R-VALUE (MIN)
EXTERIOR	SUPPLY, RETURN, PLENUMS		8.0
EXTERIOR, UNCONDITIONED OR CONDITIONED SPACE	SUPPLY, RETURN, PLENUM	< 15	NONE
UNCONDITIONED SPACE	SUPPLY, RETURN, PLENUM	> 15	5.0
ATTIC SPACE/CRAWL SPACE	SUPPLY, RETURN, PLENUM	> 15	8.0
PLENUM	SUPPLY (ONLY)	> 15	5.0

- NOTES: DUCT AND PLENUM INSULATION SHALL BE PROVIDED IN ACCORDANCE WITH 2009 ENERGY CODE
 - TEMPERATURE DIFFERENCE BASED ON AIR TEMPERATURE WITHIN THE DUCT OR PLENUM COMPARED TO THAT EXTERIOR TO THE DUCT OR PLENUM.
 - EXCEPTION: WHEN LOCATED WITHIN EQUIPMENT (WHEN EQUIPMENT IS FURNISHED LINED OR INSULATED).

GENERAL NOTES

- 1. ALL WORK TO BE DONE IN COMPLIANCE WITH ALL STATE AND LOCAL CODES AND ALL MANUFACTURER'S
- 2. SUPPLY FAN TO RUN CONSTANTLY DURING OCCUPIED PERIODS.
- MAINTAIN 10'-0" FROM ANY INTAKE TO ANY EXHAUST OR VENT.
- 4. ALL DUCT INSTALLATION SHALL CONFORM TO ASHRAE AND SMACNA STANDARDS IN REGARD TO BUT NOT LIMITED TO DUCT GAUGES, TURNING RADIUS, AND THE INSTALLATION OF TURNING VANES AND/OR EXTRACTORS, WHETHER OR NOT SHOWN ON DRAWINGS.
- 5. ALL DUCTWORK AND PIPING SHALL RUN STRAIGHT AND TRUE AND SHALL BE INSTALLED IN A WORKMANLIKE MANNER.
- 6. ALL DUCTWORK THAT REQUIRES INSULATION SHALL CONFORM WITH ALL APPLICABLE CODES. DIMENSIONS LISTED ARE <u>INSIDE FREE AREAS</u> AND DUCT SIZE MUST BE INCREASED TO ACCOUNT FOR THICKNESS OF INSULATION.
- 7. HVAC CONTRACTOR OR BALANCING AGENT SHALL TEST, ADJUST, CALIBRATE AND BALANCE THE SYSTEMS AS REQUIRED UNDER Wisconsin Code. THE BALANCE REPORT SHALL BE SUBMITTED TO THE ENGINEER, AND ONE COPY RETAINED AT THE JOBSITE.
- 8. HVAC CONTRACTOR TO FOLLOW REQUIREMENTS FOR LEAKAGE TESTING DUCTWORK AS REQUIRED BY Wisconsin Code.
- 9. ALL EQUIPMENT IS TO BE PROVIDED COMPLETE WITH OPERATION & MAINTENANCE MANUALS AND SYSTEM SCHEMATICS AS REQUIRED BY Wisconsin Code.
- 10. DUCT INSULATION TO MEET THE REQUIREMENTS OF THE 2009 IECC. PIPE INSULATION TO MEET THE REQUIREMENTS OF 2009 IECC.
- 11. ALL EXHAUST DUCTWORK TO BE BARE SHEETMETAL.
- 12. ALL HVAC EQUIPMENT TO MEET IRI, AGA, AND UL REQUIREMENTS.
- 13. ALL TRANSFER DUCTS TO BE 1" LINED DUCT OR INSULATED FLEX (R-5)
- 14. ALL LOW-VOLTAGE WIRING BY HVAC CONTRACTOR.
- 15. LOW PRESSURE ROUND DUCT AFTER HEATPUMPS TO BE 1 1/2" FIBERGLASS ABOVE CEILINGS. (R-5 MIN.)
- 16. MECHANICAL CONTRACTOR IS RESPONSIBLE FOR ALL DUCTWORK TRANSITIONS, OFFSETS, ETC. THESE DRAWINGS ARE FOR SCHEMATIC PURPOSES ONLY.

SEQUENCE OF OPERATIONS

HEAT PUMP

HEAT PUMP SHALL RUN CONTINUOUSLY DURING OCCUPIED MODE AND COMPRESSOR SHALL CYCLE TO MAINTAIN COOLING / HEATING SETPOINTS.



LIST OF SYMBOLS

---- EXISTING PIPING, DUCTWORK & EQUIPMENT

NEW PIPING, DUCTWORK & EQUIPMENT

DESCRIPTION

POINT OF CONNECTION

PIPE DROPS

PIPE RISES

PIPE END CAP

BALL VALVE

EQUIPMENT DESIGNATION EQUIPMENT NUMBER

BUTTERFLY VALVE

TEMPERATURE CONTROL VALVE

ELECTRIC WALL HEATER

ABOVE FINISHED FLOOR

WALL THERMOSTAT

WD MANUAL VOLUME DAMPER

——☐ MD MOTOR OPERATED DAMPER

CD-1 CEILING SUPPLY DIFFUSER
ROUND NECK / SQUARE FACE
AIR OLIANTITY

SD-1 SLOT DIFFUSER

_FT, _"Ø LENGTH, ROUND INLET SIZE SLOT DIFFUSER

AIR QUANTITY

AIR QUANTITY

EAG-1 EXHAUST AIR GRILLE SIZE AIR QUANTITY

RAG-1. RETURN AIR GRILLE
SIZE
AIR QUANTITY

AIR QUANTITY

AIR QUANTITY

CTG-1 CEILING TRANSFER GRILLE
SIZE
AIR QUANTITY

AIR QUANTITY

ROUND FLEXIBLE DUCT

RAR-1 RETURN AIR REGISTER
SIZE
AIR QUANTITY

SQUARE ELBOW WITH TURNING VANES

BOTTOM OF DUCT ELEVATION ABOVE FLOOR

SYMBOL

G-

 \multimap

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AFF

(T)

Building Integrity

W234 N2830 PAUL ROAD PEWAUKEE WI. 53072 PHONE (262) 523-2500 FAX (262) 523-2530 TOTAL-MECHANICAL.COM

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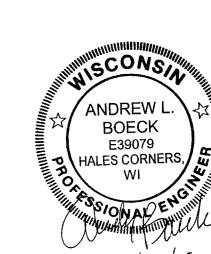
Date Revisions 1/29/18 State Plan Review

Schedules

Drawn By: BK Reviewed By: AB

Bank

4000 West Brown Deer Road Brown Deer, WI 53209



January 12, 2018 Project No